

REFLECTED CEILING PLAN GENERAL NOTES

- REFERENCE G001 FOR GENERAL NOTES, STANDARDS AND REGULATIONS, ADMINISTRATION OF THE WORK, USE OF CONSTRUCTION DOCUMENTS, DEFINITIONS, DIMENSIONS, DRAWING SET ORGANIZATION, AND OTHER DISCIPLINES.
- THERE ARE NO KNOWN EXISTING DRAWINGS OF THIS BUILDING, AND NO PROPERTY SURVEY HAS BEEN PROVIDED AT THE TIME OF THIS PRINTING.
- EXISTING CONDITIONS SHOWN ON DRAWINGS ARE BASED ON LIMITED FIELD SURVEYS. IT IS THE CONTRACTOR'S RESPONSIBILITY TO VERIFY ALL EXISTING CONDITIONS PRIOR TO BIDDING AND START OF WORK.
- ALL REFLECTED CEILING PLAN INFORMATION IS SHOWN FOR REFERENCE ONLY. ALL MEASUREMENTS TAKEN FROM GROUND LEVEL. ALL OVERHEAD ELEMENT LOCATIONS ARE APPROXIMATE AND ARE TO BE VERIFIED IN FIELD PRIOR TO BIDDING AND START OF WORK.
- REF G003 FOR FINISH SCHEDULE AND MATERIAL LEGEND.
- ALL EXISTING PARTITION, SOFFITS AND SIMILAR ADJACENT CONSTRUCTION TO REMAIN SHALL BE PATCHED AND SURFACES PREPARED TO RECEIVE FINAL FINISH. THIS INCLUDES CONCEALED CONDITIONS BEHIND FINAL FURRING FINISH OR SIMILAR TO MAINTAIN ACOUSTIC SOUND ISOLATION REQUIREMENTS.

REFLECTED CEILING PLAN KEY NOTES

- NEW GYPBD SOFFIT
- NEW CONDUIT TO MATCH NEW CLNG PT. TYP
- ALL EXIST LT FIXTURES TO REMAIN
- EXIST 2 X 4 ACT TO REMAIN
- NEW 2 X 2 ACT
- EXIST GYPBD TO REMAIN
- NEW GYPBD

REFLECTED CEILING PLAN LEGEND

- | | | | |
|------|---------------|------|-----------------------|
| SA | SUPPLY AIR | ACT | ACOUSTIC CLG TILE |
| RA | RETURN AIR | SPKR | SPEAKER |
| EXPS | EXPOSED CLG | AP | ACCESS PANEL |
| LT | LIGHT FIXTURE | WAP | WIRELESS ACCESS POINT |
| GYP | GYPSP BOARD | | |

REFLECTED CLNG PLANS


SHEET TITLE:

A301

SD PRICING

DRAWN BY: TP / EGH ISSUE DATE: 3 FEBRUARY 2023

02 REFLECTED CEILING PLAN: MEZZANINE LEVEL
 A301

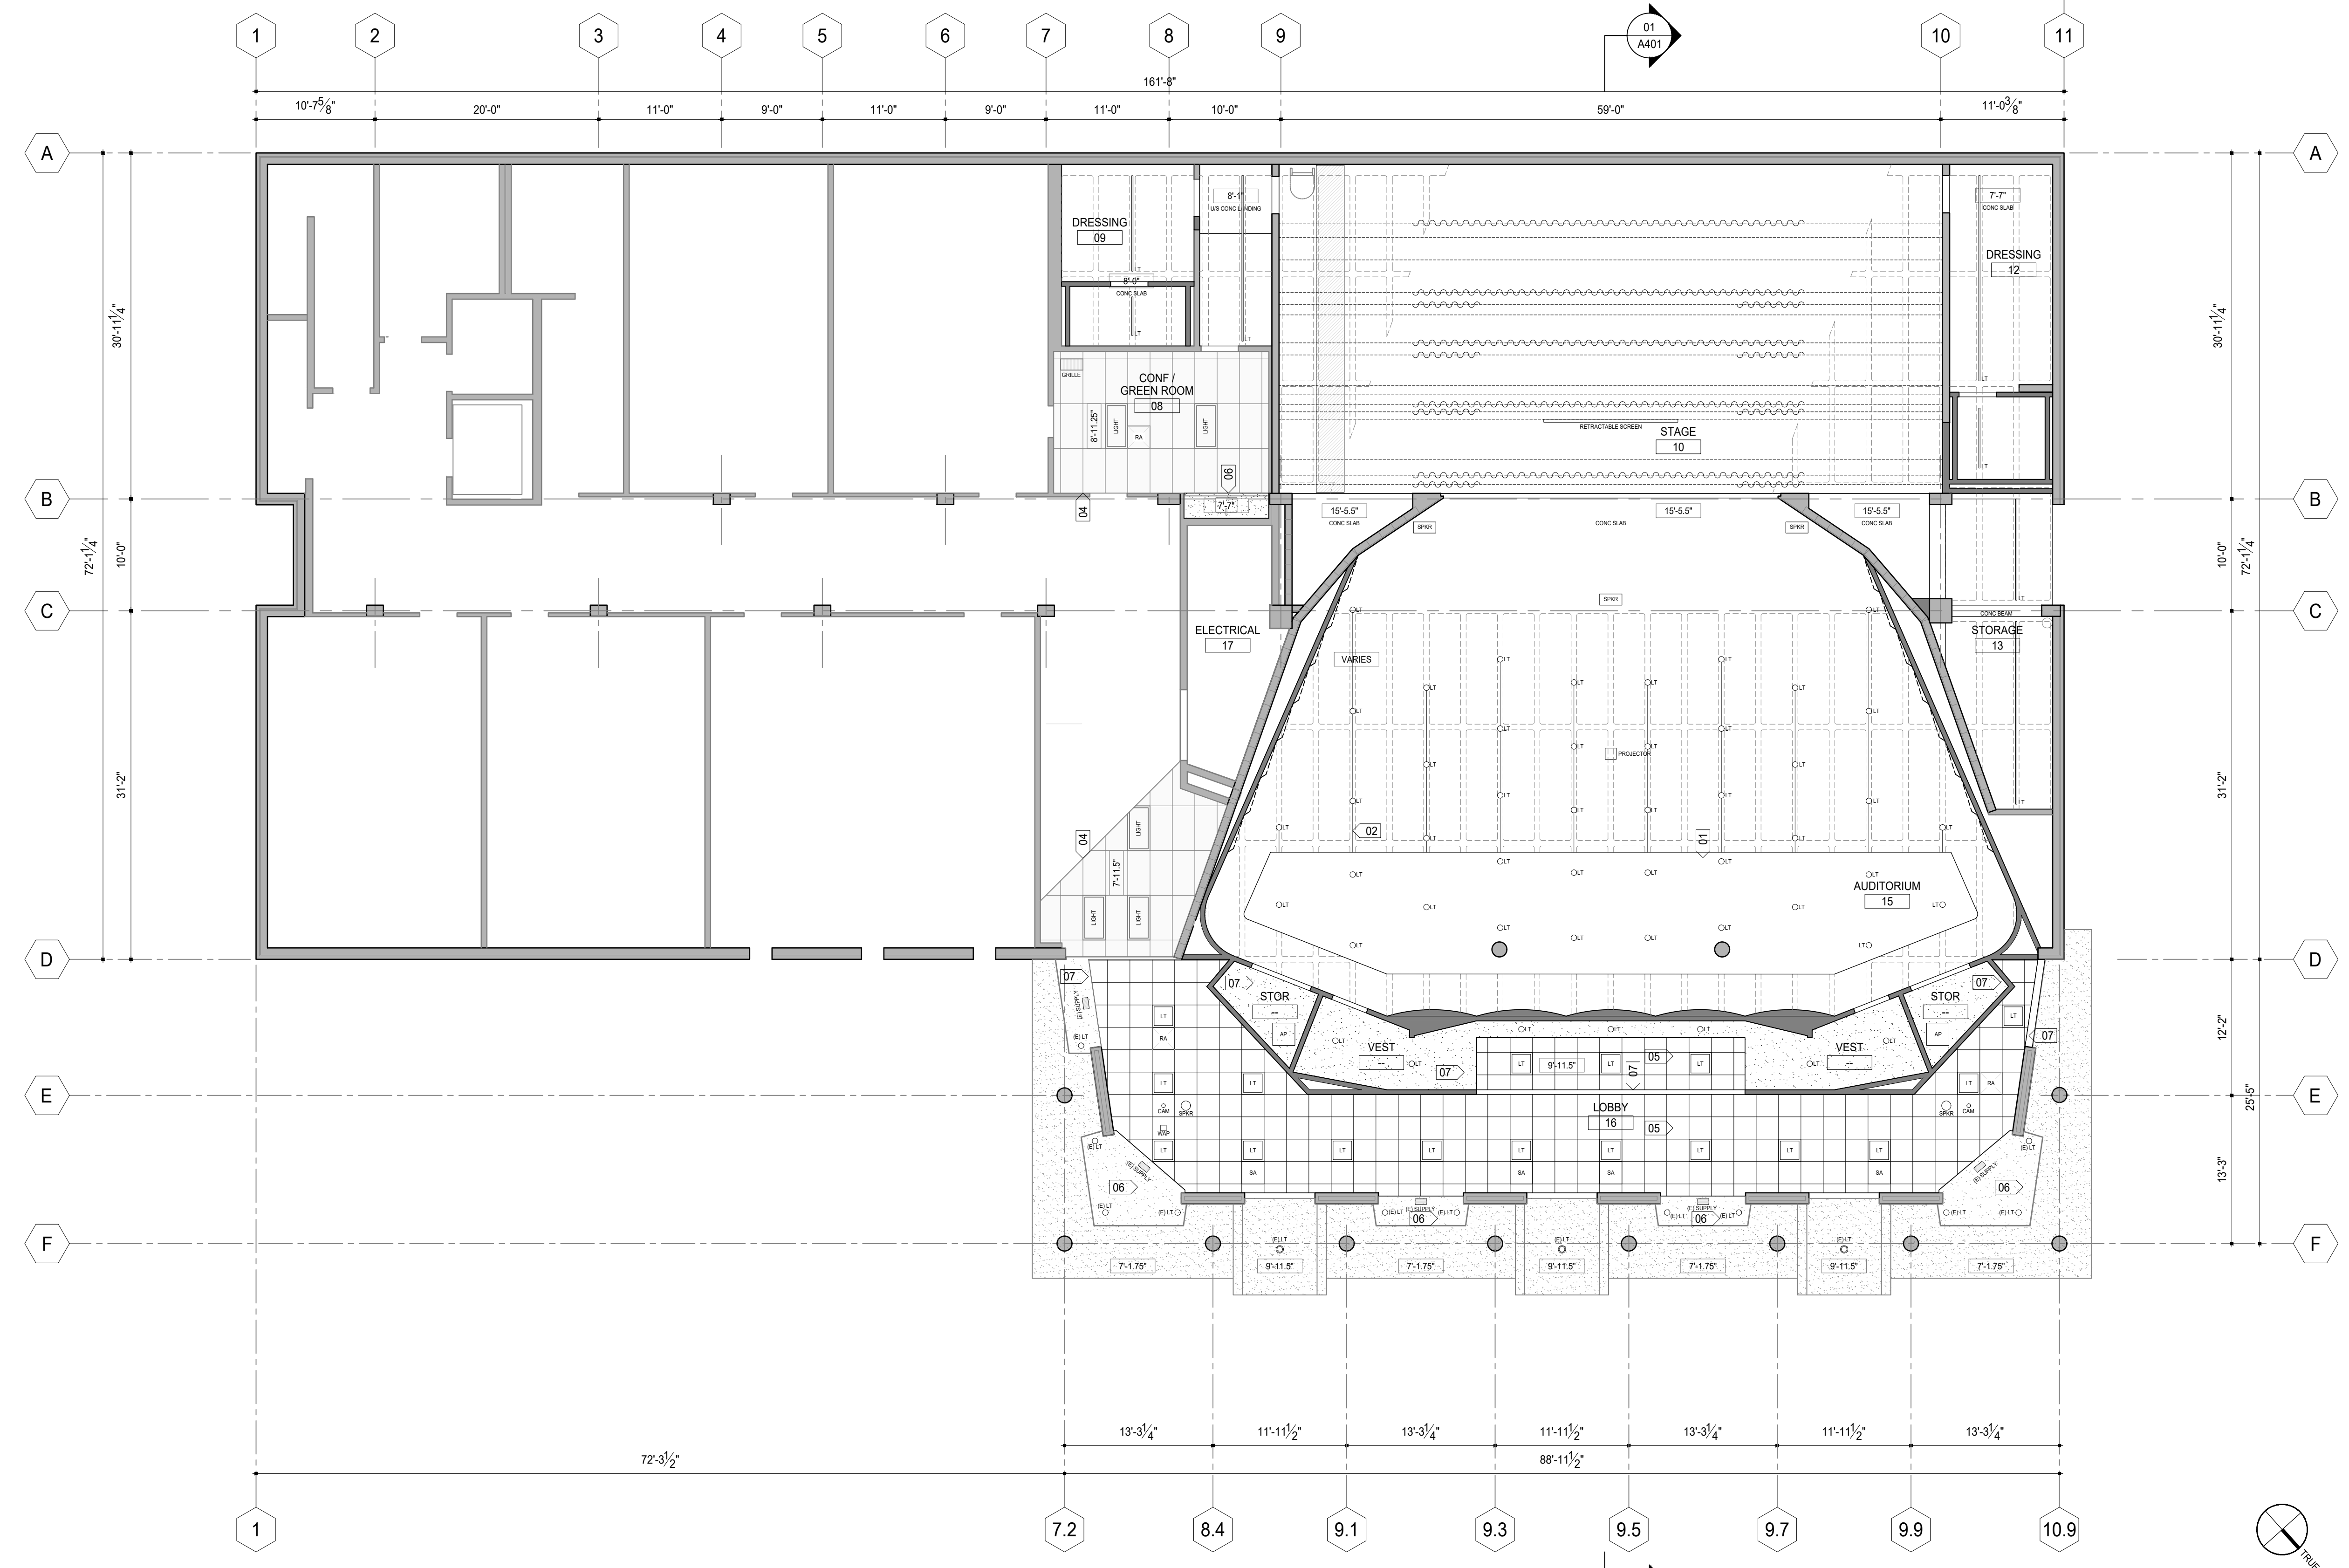

1/8"=1'-0" 0 2' 4' 8' 16 FT

01 REFLECTED CEILING PLAN: GROUND LEVEL
 A301

© 2023 pattern ives llc. ALL REPRODUCTION AND INTELLECTUAL PROPERTY RIGHTS RESERVED. ORIGINAL DRAWING IS 24" X 42" W.

LU PROJECT NUMBER: XXXX

LINCOLN UNIVERSITY MISSOURI - PAWLEY THEATER RENOVATION

